#### PROJECT

# Project Name


Enter address here

#### OWNER


Owner's Name Owner's Street Address


### SYMBOL LEGEND

## **REFERENCES** DETAIL / SHEET NUMBER **BLOW-UP BOUNDARY BLDG. SECTION & SHEET** DETAIL / SHEET NUMBER INTERIOR ELEVATION NUMBER SHEET NUMBER

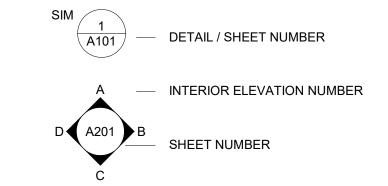

EXTERIOR ELEVATION NUMBER

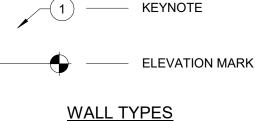


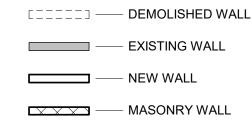

#### **IDENTIFICATION TAGS**

— CONCRETE WALL

Room name	— ROOM
150 SF	— ROOM AREA

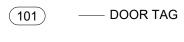

WINDOW TAG

#### **VICINITY MAP**



#### PROJECT TEAM

**ARCHITECT** NAME OF ARCHITECT Architect Address Phone Number:

CONTACT: NAME OF CONTACT

STRUCTURAL ENGINEER

NAME OF ENGINEER Engineer Address: Phone Number:

METHANE HAZARD SITE CONTACT: NAME OF CONTACT SPECIAL GRADING AREA (BOE) CONSTRUCTION TYPE

> BUILDABLE AREA/ FLOOR AREA RATIO
> BUILDABLE AREA 11 1,528.18 SF

ASSESSOR (APN)

MAP REFERENCE

BLOCK

MAP SHEET

**ZONING INFO** 

**OCCUPANCY** 

LOT AREA (ZIMAS)

ABUTTING ALLEY

**ABUTTING 1/2 ALLEY** 

LOT AREA W/

FLOOD ZONE

ZONING

FAR (BY RIGHT) 34,584.54 SF (BUILDABLE AREA X FAR = 11,528.18 SF X 3.0) FLOOR AREA (BY RIGHT) 24,101 SF (REFER TO A1.01 FOR FLOOR AREA FLOOR AREA PROPOSED CALCULATIONS)

2.09 (24,101 SF / 11,528.18 SF = 2.09)

ABUTTING ALLEY 1/2 ALLEY AREA: 866.7 SF (86'-" X 10' = 866.7 SF) LOT AREA W/1/2 ALLEY 14,765.19 + 886.7 = 15,631.86

**ZONING & BUILDING SUMMARY** 

000000000

M B 00-00/00

000-00000 & 0000000

14,765.19 + 886.7 = 15,631.86

TYPE V-A FULLY SPRINKLERED

**OUTSIDE FLOOD ZONE** 

(ZI) ZI-2358 RIVER IMPROVEMENT OVERLAY DISTRICT

1/2 ALLEY AREA: 866.7 SF (86'-8" X 10' = 866.7 SF)

TR 0000

DENSITY RATIO 15,631.86 SQ FT\* / 400 SQ FT = 39.1 = 39 UNITS ALLOWABLE UNITS (\*LOT AREA) PROPOSED UNITS 18 UNITS < 39 UNITS

SETBACKS FOR 3 STORIES (PER LAMC SECTION 12.11C)

<u>REQUIRED</u> FRONT YARD REAR YARD 15'-0" 15'-0" (5'-0"+10'-0"ALLEY = 15'-0")

SIDE YARD (5'-0" + 1FT/STORY ABOVE 2ND)

ALLOWABLE BUILDING HEIGHT & STORIES (PER LAMC 12.21.1)

**BUILDING HEIGHT** STORIES 3 STORIES 3 STORIES

REQUIRED VEHICULAR PARKING (BY RIGHT PER LAMC)

UNIT COUNT 1 BEDROOM (1-BR) 18 UNITS TOTAL PARKING REQUIREMENTS (COMBINATION OF USES 12.21AJ)

H/C PARKING STALLS:

**PARKING STALLS** 27 STALLS REQUIRED

1.684 SF 4 STALL/1000SF (1684/250=6.7) 7 STALLS REQUIRED **34 STALLS REQUIRED PER LAMC\*** \*(AB 2097 NEAR 1/2 MILE OF TRANSIT STOP): 0 CAR STALLS REQUIRED PROPOSED PARKING (1 H/C + 9 standard + 10 compact) = 20 STALLS PROVIDED\*

1 STALL REQUIRED 1 STALL PROVIDED

<u>BICYCLE PARKING SUMMARY (BY RIGHT PER LAMC)</u> BICYCLE CLASSIFICATION / RATIO SPACES REQUIRED SPACES PROVIDED 18 SPACES 1 SPACE/ UNIT FOR 1-25 DU

LONG TERM (RETAIL SPACE:1,638SF) 2 SPACES 6 SPACES 1 SPACE/ 2,000FT (MIN 2) 24 LONG-TERM SPACES

SHORT-TERM 2 SPACES 2 SPACES 1 SPACE/10 UNITS FOR 1-25 DU (18DU/10 = 1.8)RETAIL TERM (RETAIL SPACE:1,638SF) 2 SPACES 2 SPACES
4 SHORT-TERM SPACES 1 SPACE/ 2,000FT (MIN 2)

OPEN SPACE AREA CALCULATION (PER LAMC 12.21G)
<3 HABITABLE ROOMS 100 SF / UNIT ( STUDIO & 1-BR UNITS)

TREE PLANTING CALCULATION (PER LAMC 12.21G) 1) TREE FOR EVERY (4) DWELLING UNITS

18 DWELLING UNITS / 4 = 4.5 = 5 TREES REQUIRED

**5 TREES PROVIDED** 

#### PROJECT DESCRIPTION

NEW CONSTRUCTION, 3-STORY MIXED USE PROJECT, W/ RETAIL SPACE & 18 MARKET RATE UNITS

100% BY-RIGHT OCCUPANCY FIRE SPRINKLER FIRE ALARM

FULLY SPRINKLERED IN ACCORDANCE WITH NFPA 13 MANUAL FIRE ALARM THIS PROJECT IS 100% PRIVATELY FUNDED.

#### UNDER SEPARATE PERMIT

**ELECTRICAL WORK** 

PROJECT FUNDING

MECHANICAL WORK PLUMBING WORK

FIRE SPRINKLER (SPRINKLER SYSTEM TO BE APPROVED BY CITY PLUMBING DIVISION PRIOR TO INSTALLATION)

#### APPLICABLE CODES

CONSTRUCTION SHALL ADHERE TO THE LATEST EDITION OF CODES ADOPTED BY LOCAL GOVERNMENT AGENCIES. THESE SHALL INCLUDE: 2023 LOS ANGELES BUILDING CODE (LABC) 2023 LOS ANGELES MUNICIPAL CODE (LAMO 2023 LOS ANGELES GREEN BUILDING CODE (LAGBC) 2023 LOS ANGELES FIRE CODE (LAFC) 2023 LOS ANGELES PLUMBING CODE (LAPC)

2023 LOS ANGELES MECHANICAL CODE (LAMC) 2023 LOS ANGELES ELECTRICAL CODE (LAEC)

**GENERAL NOTES** IN THE EVENT DISCREPANCIES OCCUR IN THE DRAWINGS CONTACT

THE ARCHITECT FOR RESOLUTION. THESE PLANS ARE FOR GENERAL CONSTRUCTION PURPOSES ONLY. THEY ARE NOT EXHAUSTIVELY DETAILED OR FULLY SPECIFIED. IT IS THE RESPONSIBILITY OF THE CONTRACTOR TO SELECT, VERIFY,

RESOLVE, AND INSTALL ALL EQUIPMENT WHERE DISCREPANCIES OCCUR BETWEEN SOILS REPORT, CIVIL, LANDSCAPE OR STRUCTURAL DRAWINGS AND ARCHITECTURAL DRAWINGS, CONSULT ARCHITECT

STRUCTURAL OBSERVATION SHALL BE REQUIRED BY THE ENGINEER FOR STRUCTURAL CONFORMANCE TO THE APPROVED PLANS. DIMENSIONS TAKE PRECEDENCE OVER SCALE. PRIOR TO THE CONTRACTOR REQUESTING A FOUNDATION

INSPECTION, THE SOILS ENGINEER SHALL ADVISE THE BUILDING OFFICIAL IN WRITING THAT: THE BUILDING EXCAVATION AND BUILDING PAD WILL BE

PREPARED IN ACCORDANCE WITH THE SOILS REPORT. THE FOUNDATION, FRAMING, AND GRADING COMPLY WITH THE SOILS REPORT AND APPROVED PLANS. THE DRAINAGE SYSTEM IS IN ACCORDANCE WITH THE SOILS

A CERTIFIED WATER PROOFING CONTRACTOR SHALL INSPECT THE WATERPROOFING AND SUBMIT A CERTIFICATION THAT WATER PROOFING COMPLIES WITH APPROVED PLANS

DWELLING IS TO BE PROVIDED WITH COMFORT HEATING FACILITIES CAPABLE OF MAINTAINING 68 DEG.F AT 3 FT. ABOVE THE FLOOR CBC

THE ARCHITECT WILL HAVE LIMITED OBSERVATION DURING THE CONSTRUCTION OF THE PROJECT. THE CONTRACTOR IS SOLELY RESPONSIBLE FOR THE QUALITY CONTROL AND CONSTRUCTION STANDARDS FOR THIS PROJECT UNLESS OTHERWISE NOTED (U.O.N.). ALL LOCAL FIRE ORDINACES AND MUNICIPAL CODES SHALL BE

APPLIED FINISH GRADES SHALL PROVIDE DRAINAGE AWAY FROM RESIDENCE. ALL ROOF DRAINAGE SHALL BE PIPED TO APPROVED DRAINAGE

PRIOR TO CONSTRUCTION, THE CONTRACTOR SHALL EMPLOY THE SOILS ENGINEER TO TEST THE RELATIVE SOIL DENSITY OF THE SITE AND VERIFY IN WRITING THAT THE RELATIVE SOIL DENSITY MEETS OR EXCEEDS THE REQUIREMENTS SPECIFIED IN THE SOILS REPORT. IF THE RELATIVE SOIL DENSITY DOES NOT MEET THE SPECIFICATIONS STATED IN THE SOILS REPORT, THE CONTRACTOR SHALL FOLLOW THE SOILS ENGINEER'S RECOMMENDATIONS FOR RECOMPACTION.

NOISE LIMITS: CONSTRUCTION WORK WITHIN 300 FT OF A RESIDENTIAL PROPERTY IS LIMITED TO THE HOURS OF SEVEN A.M. TO SEVEN P.M. MONDAY THROUGH FRIDAY, AND EIGHT A.M. TO SIX P.M. ON SATURDAY. NO WORK SHALL BE PERFORMED ON THE FOLLOWING PUBLIC HOLIDAYS: NEW YEAR'S DAY, INDEPENDENCE DAY, THANKSGIVING, CHRISTMAS, MEMORIAL DAY, AND LABOR DAY.

#### DRAWING INDEX

COVER SHEET A1.01 GENERAL INFO A2.00 SITE PLAN A2.01 FIRST LEVEL PLAN SECOND LEVEL PLAN A2.03 THIRD LEVEL PLAN A2.04 **ROOF PLAN** A3.00 **ELEVATIONS ELEVATIONS** A3.01 SECTIONS A4.00 A5.00 WALL TYPES & DETAILS A8.00 **SCHEDULES** A9.00 **ENLARGED PLANS** Grand total: 13

#### Architect of Record

The enclosed drawings, designs, ideas and arrangements, as contracted with their clients and consultants, are and shall remain the property of The Architect of Record. No part thereof shall be copied, disclosed to others, or used in connection with any other work or project without the written consent of the above. Visual contact with these prints shall constitute conclusive evidence of

these restrictions.

Los Angeles, CA 90015 Cell: 213-xxx-xxx Email:xxxe.com

Project Name Project address Project address



Owner's Name Owner's Street Address City, CA 90015


COVER SHEET

#### **CONSTRUCTION DOCUMENTS**

PROJECT NUMBER Project Number Submission

Date	Issue Date
Drawn by	XX
Checked by	XX

A1.00

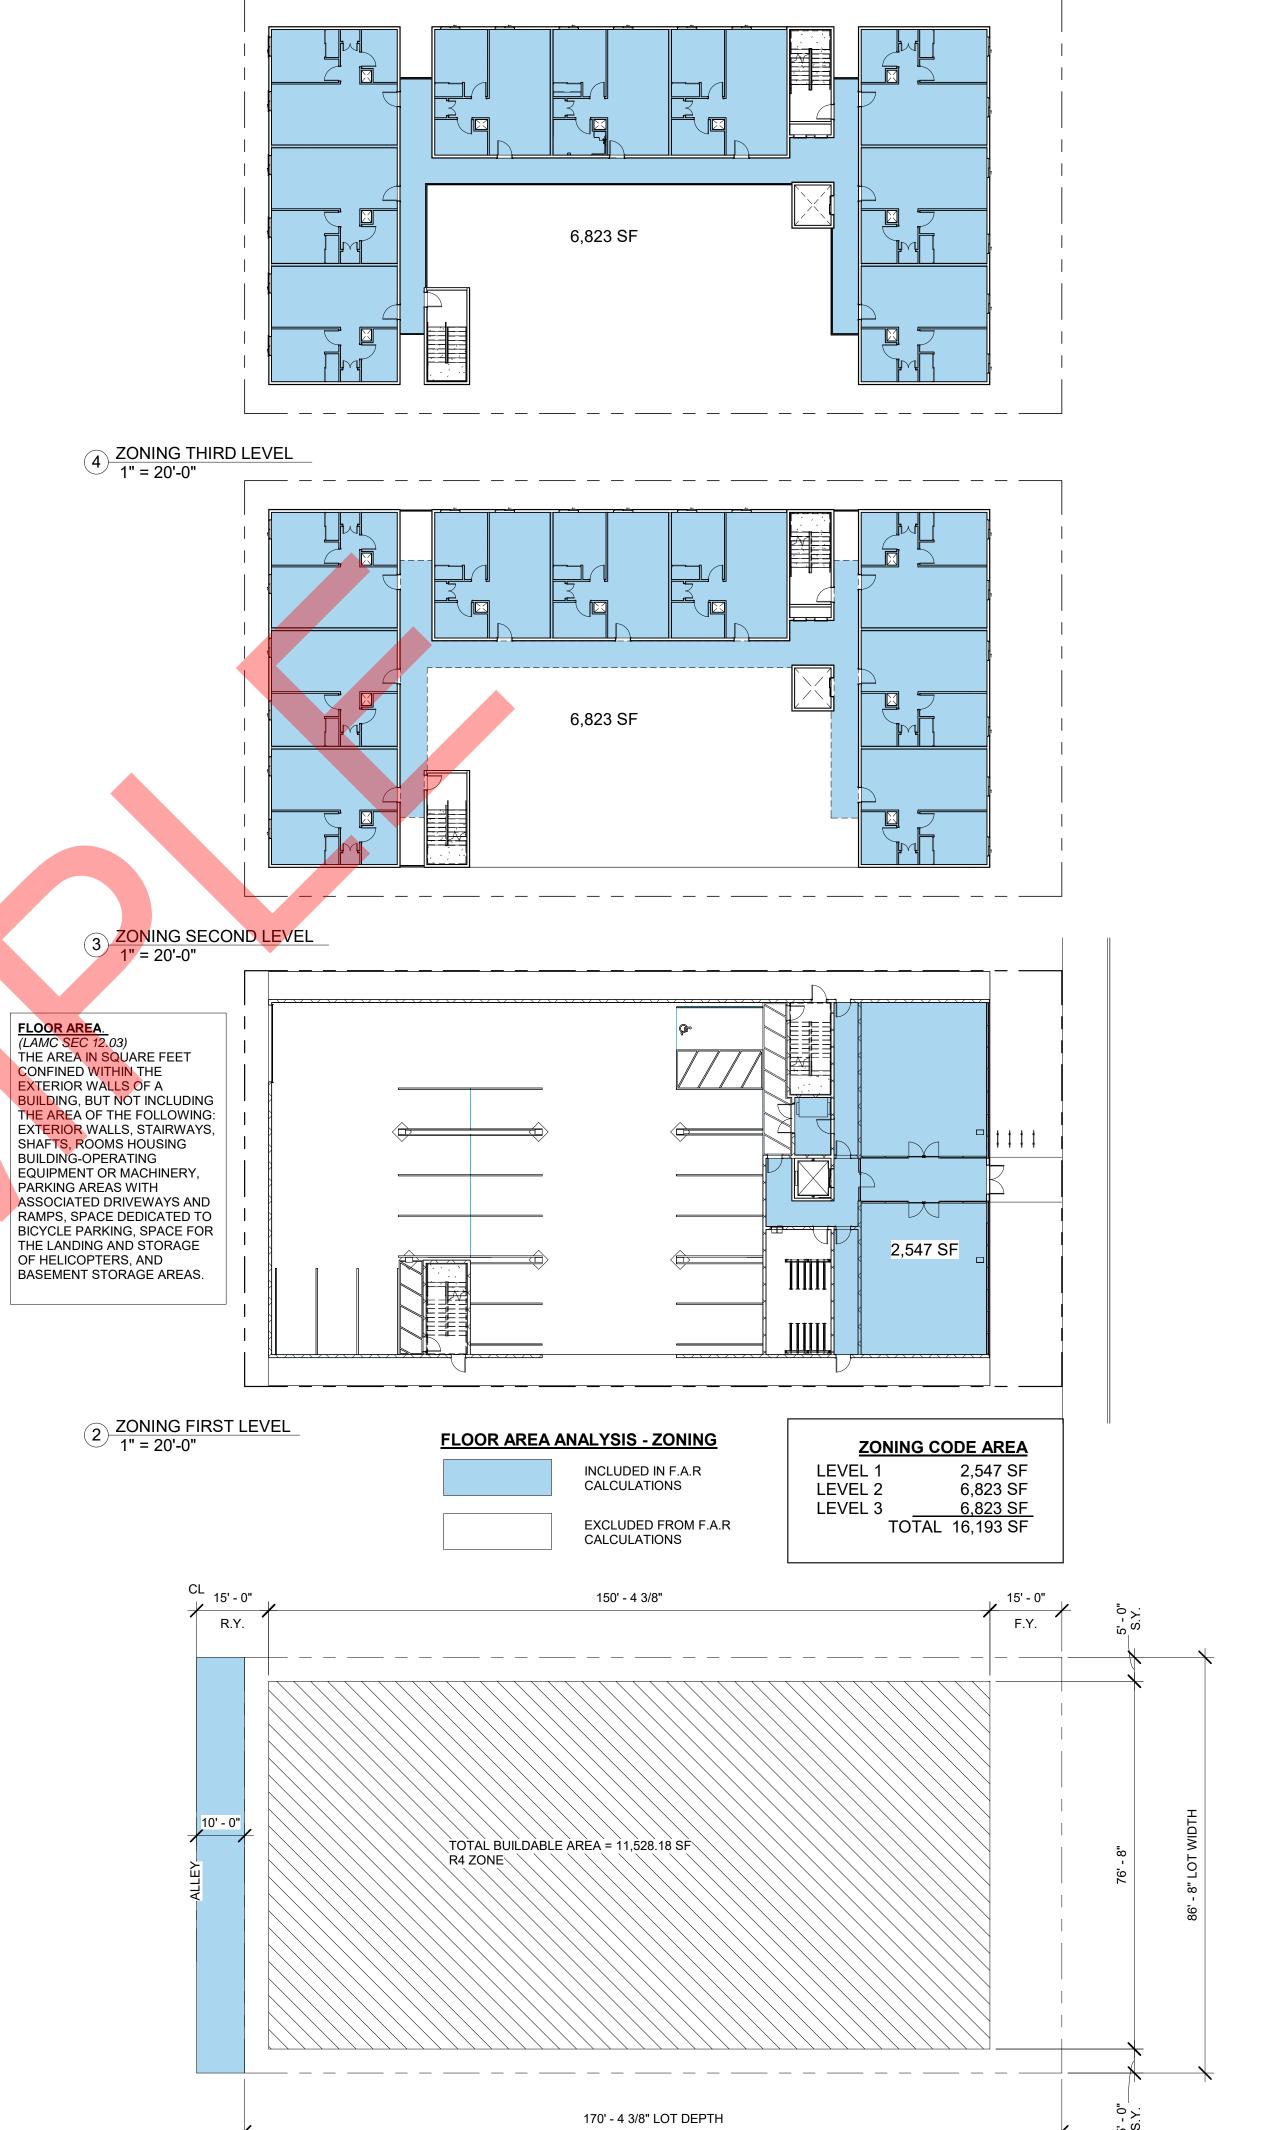

1" = 20'-0"

The enclosed drawings, designs, ideas and arrangements, as contracted with their clients and consultants, are and shall remain the property of The Architect of Record. No part thereof shall be copied, disclosed to others, or used in connection with any other work or project without the written consent of the above. Visual contact with these prints shall constitute conclusive evidence of these restrictions.

**CONSTRUCTION NOTES:** 

Architect of Record

Los Angeles, CA 90015 C e II : 2 1 3 - x x x - x x x x E m a iI : x x x@.com

> Project Name Project address Project address



Owner's Name Owner's Street Address City, CA 90015

**GENERAL INFO** 

Scale

CONSTRUCTION DOCUMENTS

PROJECT NUMBER

Project Number Submission Date

Issue Date Drawn by XX Checked by XX

A1.01

As indicated

The enclosed drawings, designs, ideas and arrangements, as contracted with their clients and consultants, are and shall remain the property of The Architect of Record. No part thereof shall be copied, disclosed to others, or used in connection with any other work or project without the written consent of the above. Visual contact with these prints shall constitute conclusive evidence of these restrictions.

#### **CONSTRUCTION NOTES:**

- 1. ROOFTOP HVAC UNIT TYPICAL)
- 2. ENTRY CANOPY
- 3. SHORT TERM BICYCLE STORAGE
- 4. 42" HIGH WALL
- 5. 6'-0" HIGH WALL

Architect of Record

Los Angeles, CA 90015 Cell: 213 - x x x - x x x E m a il: x x x@.com

Project Name
Project address
Project address



Owner's Name
Owner's Street Address
City, CA 90015

≝ SITE PLAN

CONSTRUCTION DOCUMENTS

PROJECT NUMBER Project Number

No. Date Submission

Date Issue Date
Drawn by XX
Checked by XX


A2.00

1/8" = 1'-0"

N

1 SITE PLAN 1/8" = 1'-0"

20/2023 11:10:19 AM

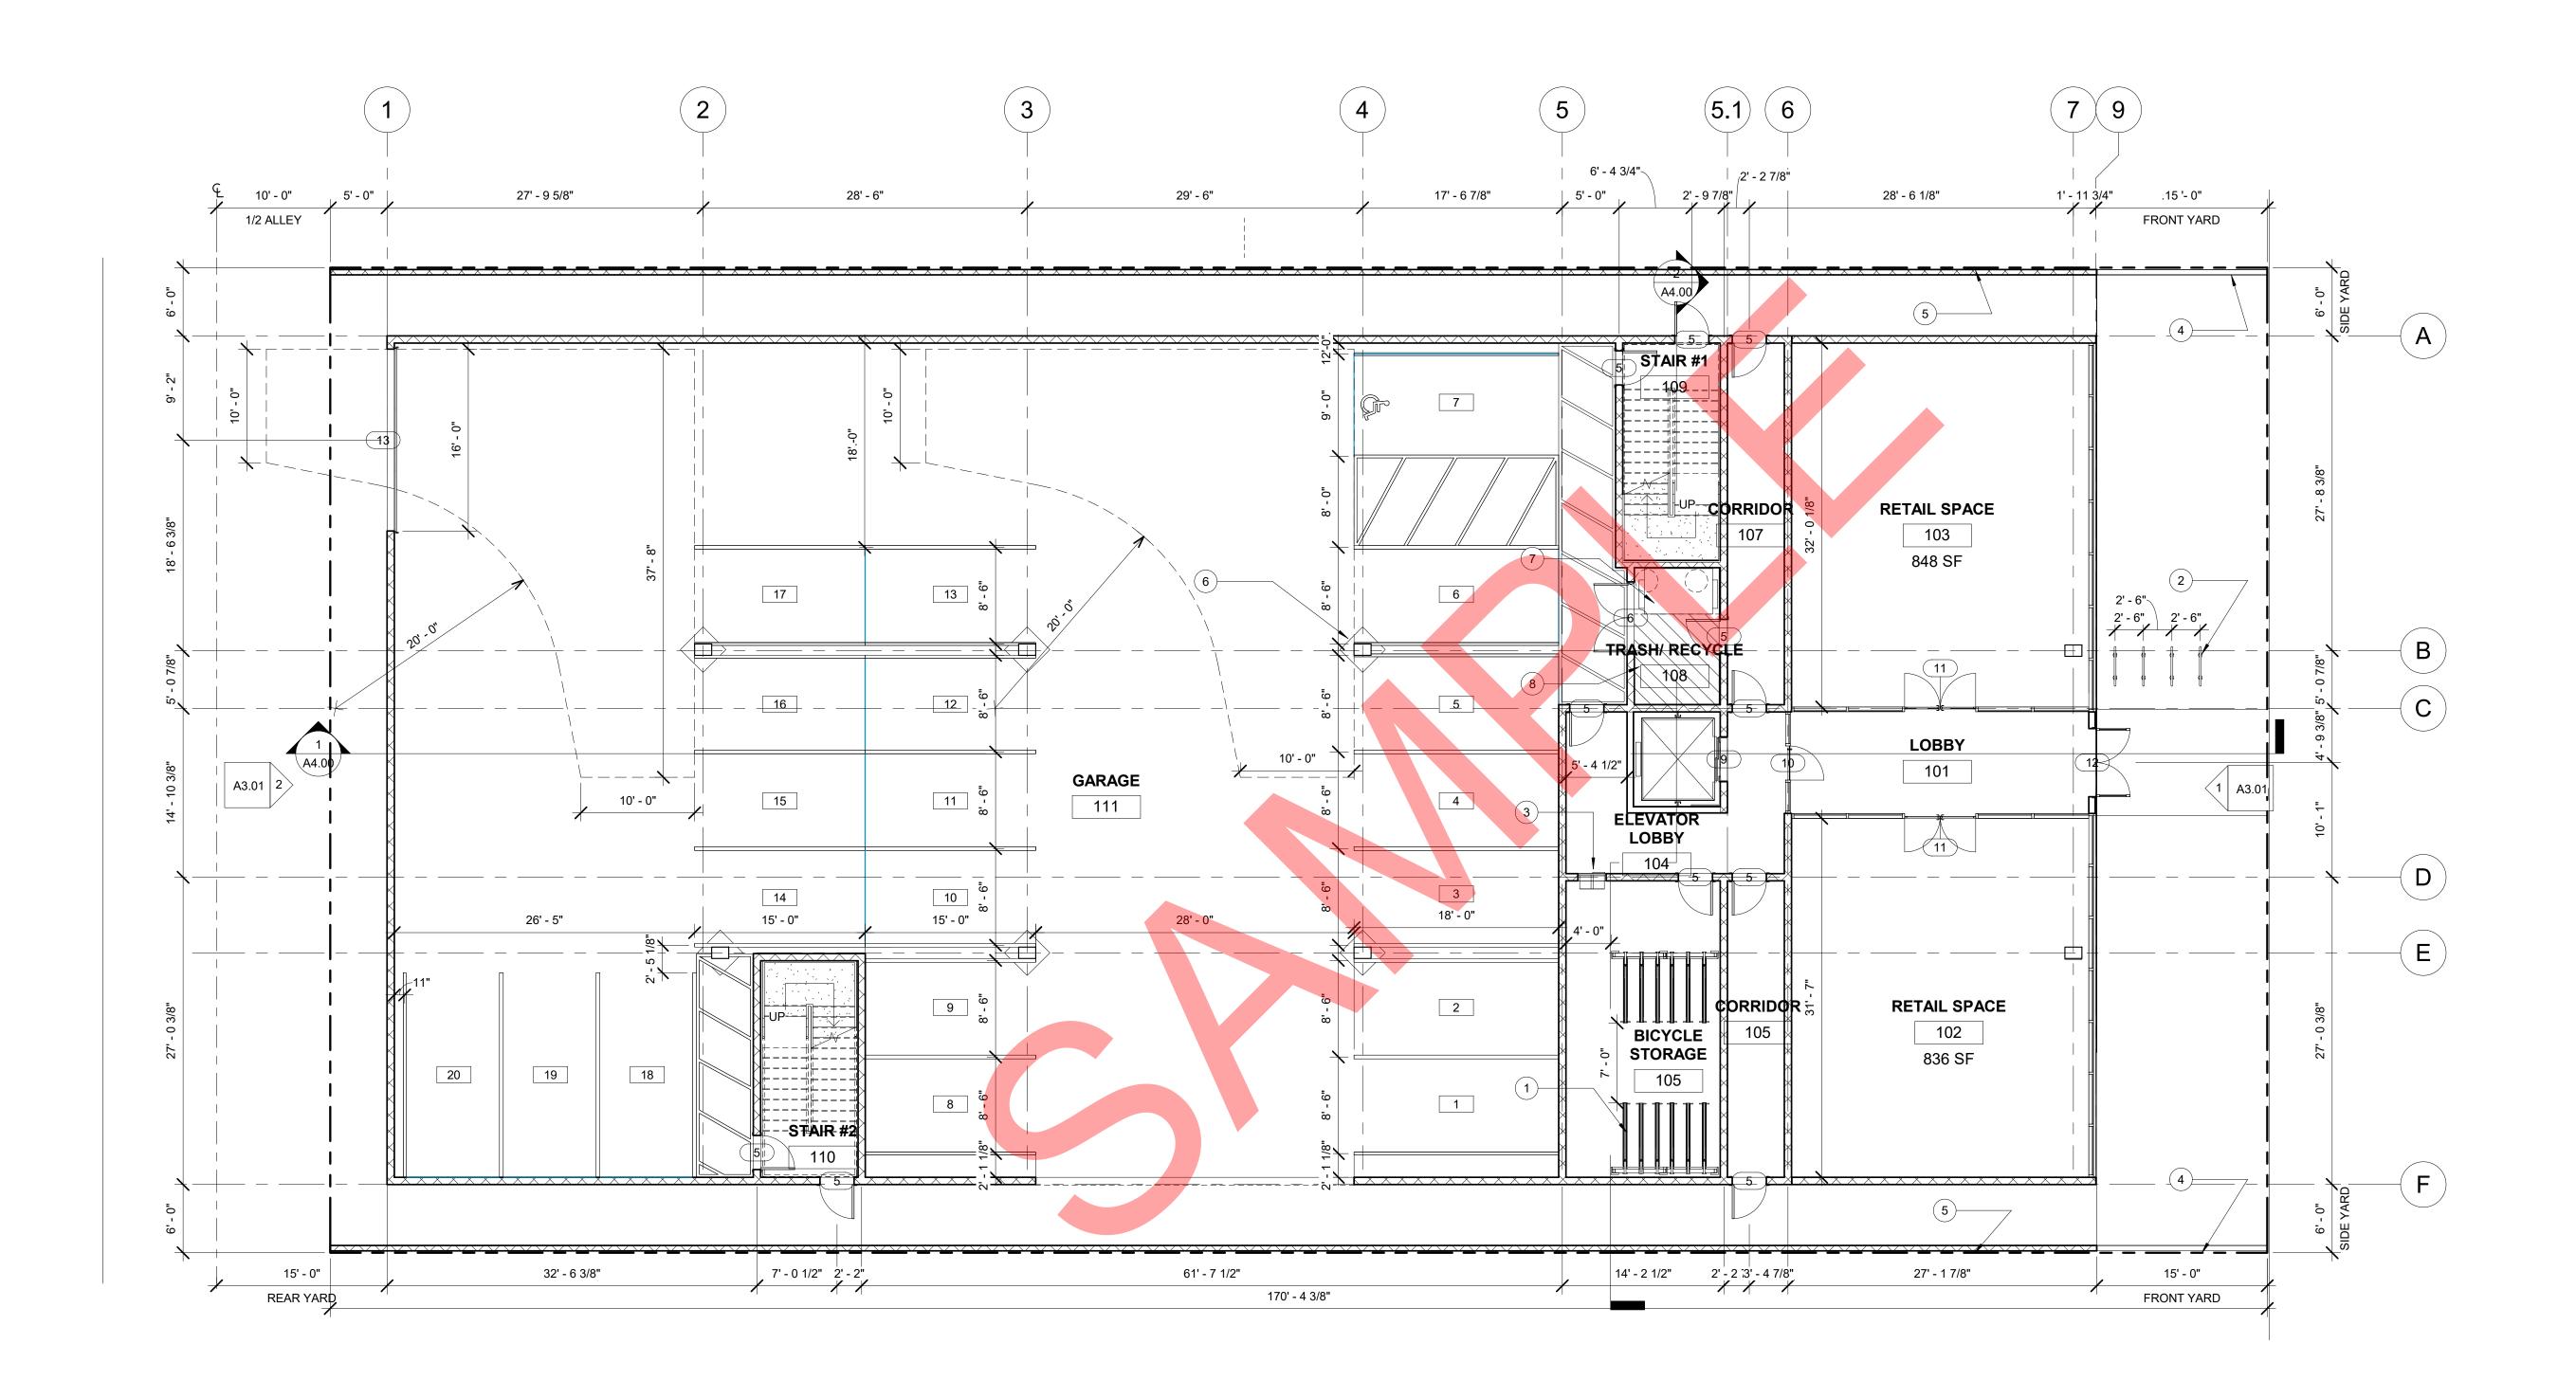

1 FIRST LEVEL 1/8" = 1'-0" The enclosed drawings, designs, ideas and arrangements, as contracted with their clients and consultants, are and shall remain the property of The Architect of Record. No part thereof shall be copied, disclosed to others, or used in connection with any other work or project without the written consent of the above. Visual contact with these prints shall constitute conclusive evidence of these restrictions.

#### **CONSTRUCTION NOTES:**

- 1. TWO TIERED LIFT-ASSIST BIKE STORAGE
- (24 SPOTS IN TOTAL)
  2. SHORT TERM BICYCLE STORAGE
- 3. MAILBOX
- 4. 42" HIGH CMU WALL
- 5. 6'-0" CMU WALL (IB: P/BC 2020-096)
- 6. S.O.G CONTROL JOINT
- 7. 4 YARD TRASH DUMPSTER
- 8. 60SF RECYCLE AREA



Los Angeles, CA 90015 Cell: 213 - x x x - x x x E m ail: x x x@.com

Project Name
Project address
Project address



Owner's Name
Owner's Street Address
City, CA 90015


FIRST LEVEL PLAN

#### CONSTRUCTION DOCUMENTS

PROJECT NUMBER		Project Number
No.	Date	Submission

Date	Issue Date
Drawn by	XX
Checked by	XX

A2.01

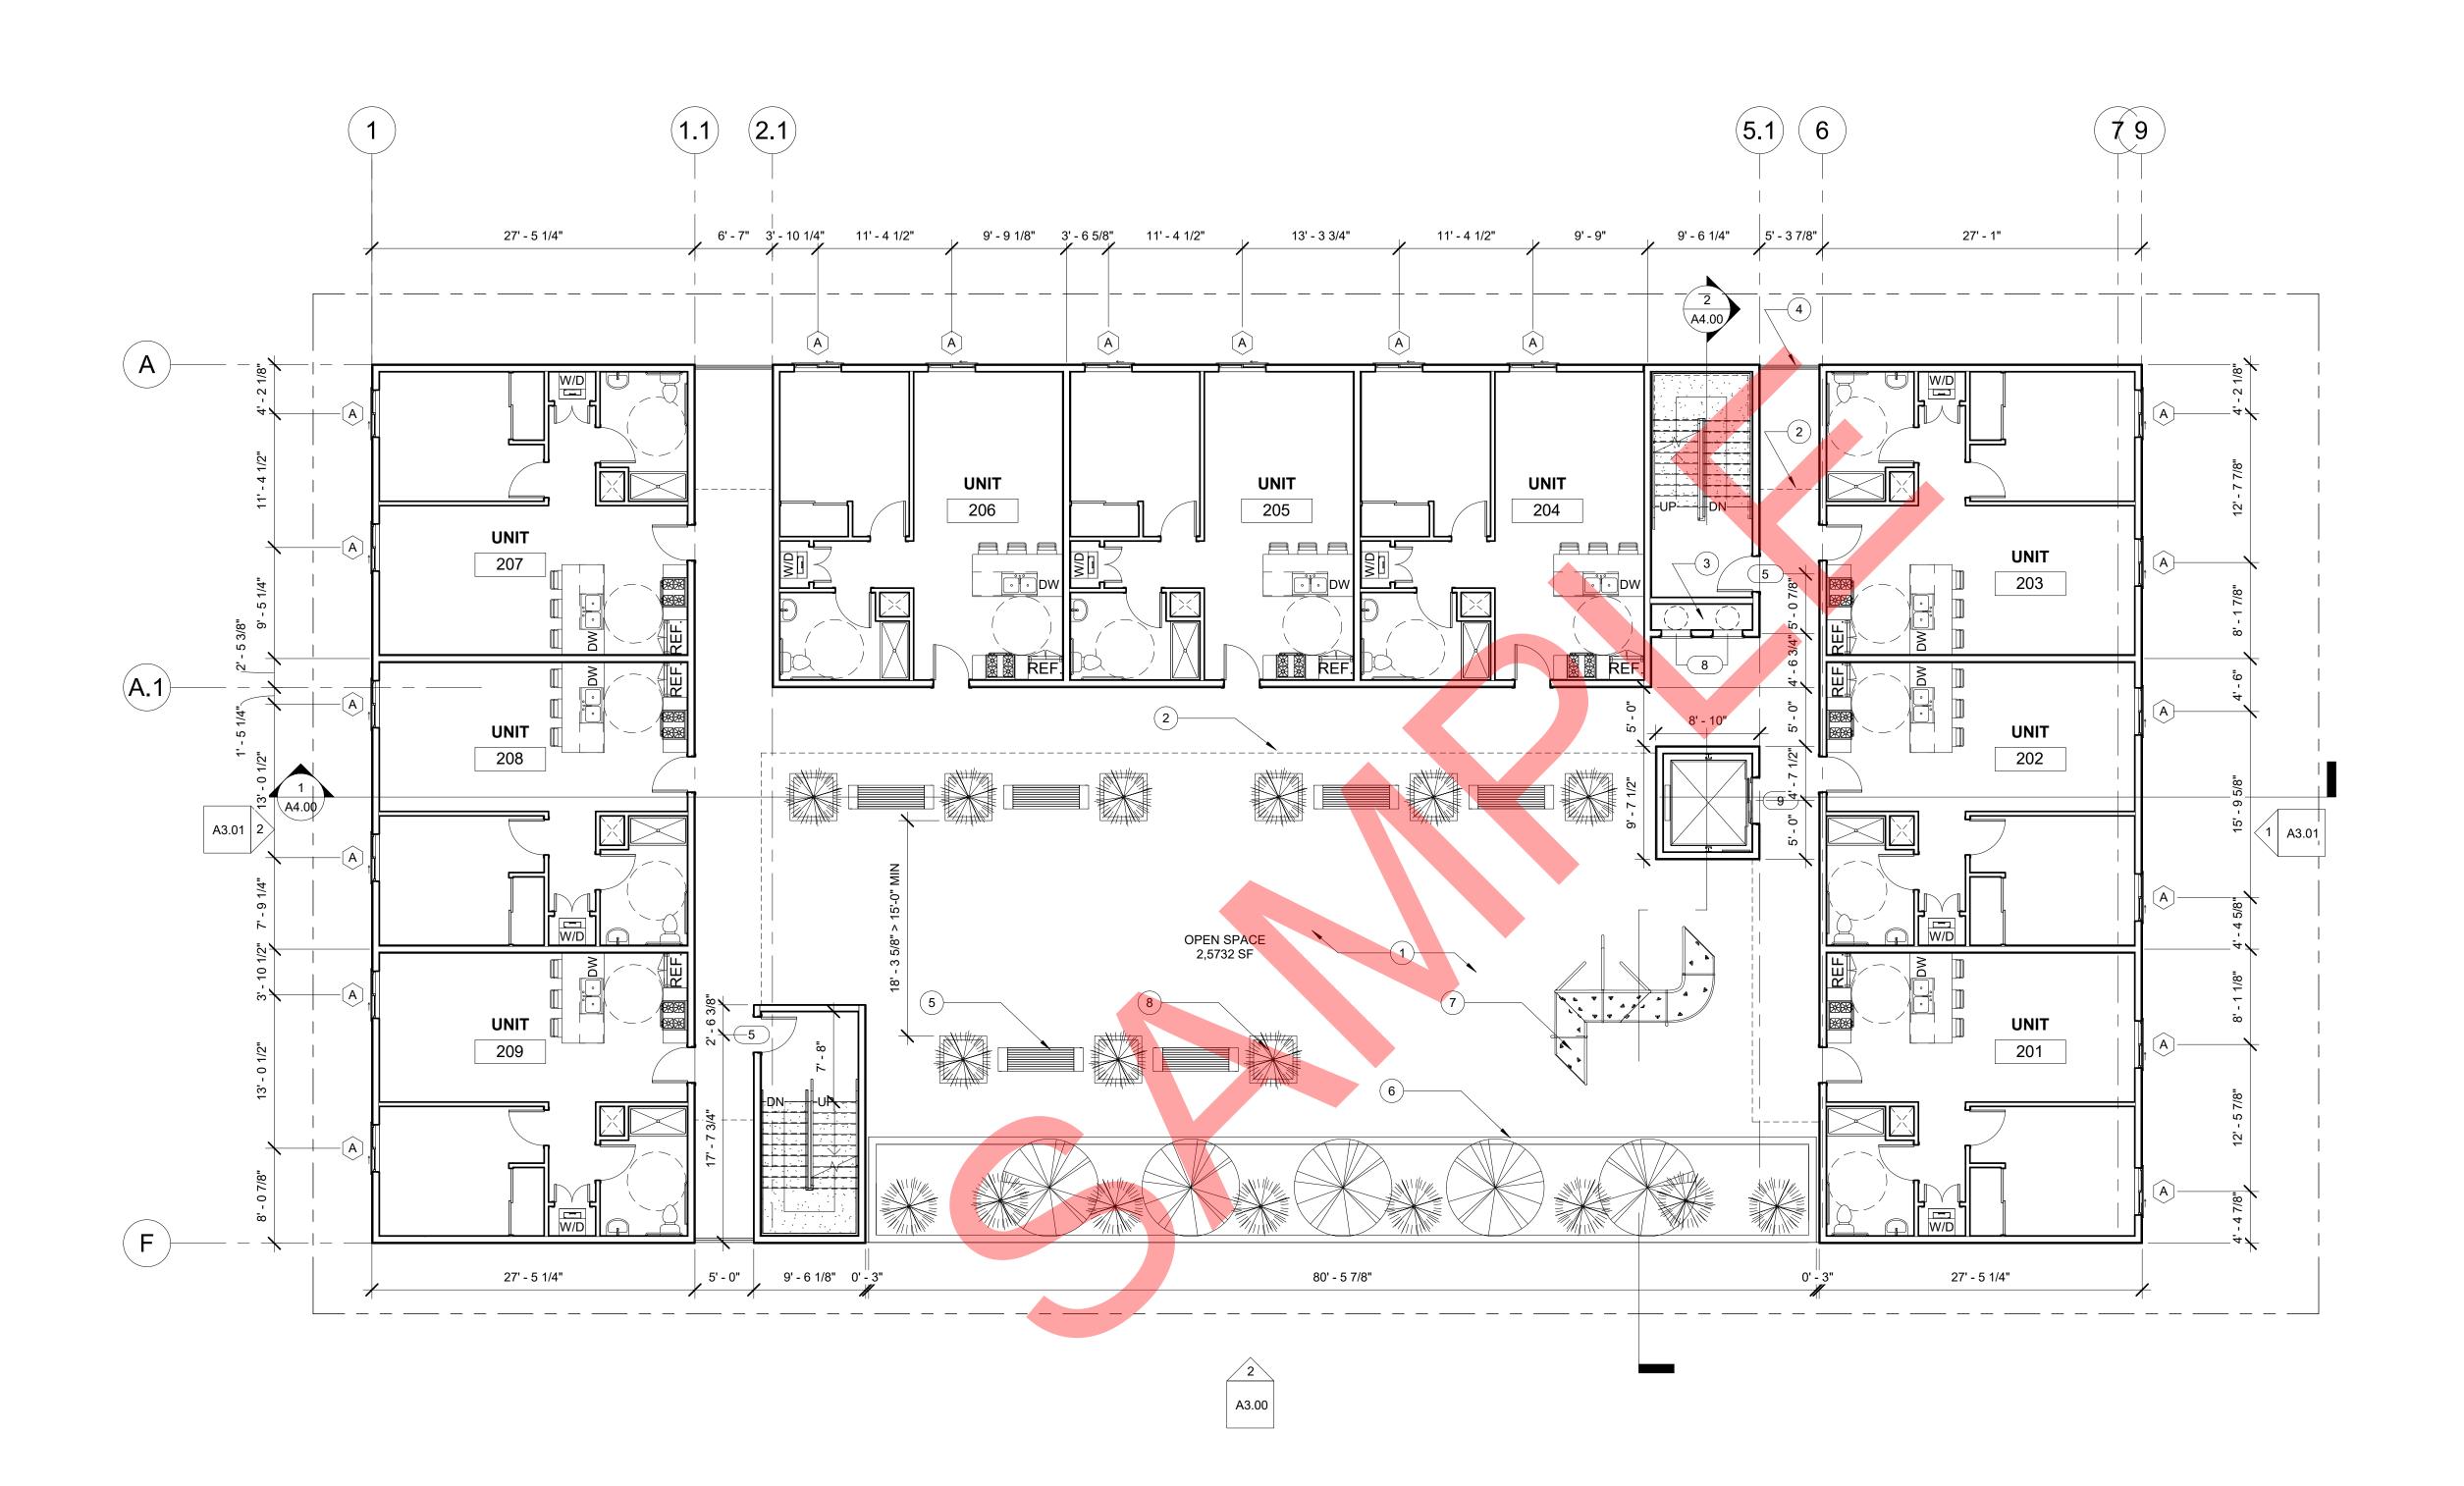


1 SECOND LEVEL 1/8" = 1'-0"

The enclosed drawings, designs, ideas and arrangements, as contracted with their clients and consultants, are and shall remain the property of The Architect of Record. No part thereof shall be copied, disclosed to others, or used in connection with any other work or project without the written consent of the above. Visual contact with these prints shall constitute conclusive evidence of these restrictions.

#### **CONSTRUCTION NOTES:**

- CONCRETE TOPPING SLAB
- WALKWAY ABOVE
- 3. TRASH & RECYCLE CHUTE
- 4. 42" HIGH RAILING
- 5. 48" SQUARE PLANTER BOX W/LANDSCAPE
- 6. 42" HIGH CMU WALL PLAY STRUCTURE
- 8. CONCRETE & WOOD SLATE BENCH

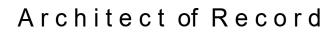

Los Angeles, CA 90015 C e II : 2 1 3 - x x x - x x x x E m a i I : x x x@.com

> Project Name Project address Project address



- Owner's Name Owner's Street Address City, CA 90015
- SECOND LEVEL PLAN


#### CONSTRUCTION DOCUMENTS

PROJECT NU	MBER	Project Number
No.	Date	Submission

Date	Issue Date
Drawn by	XX
Checked by	XX

A2.02



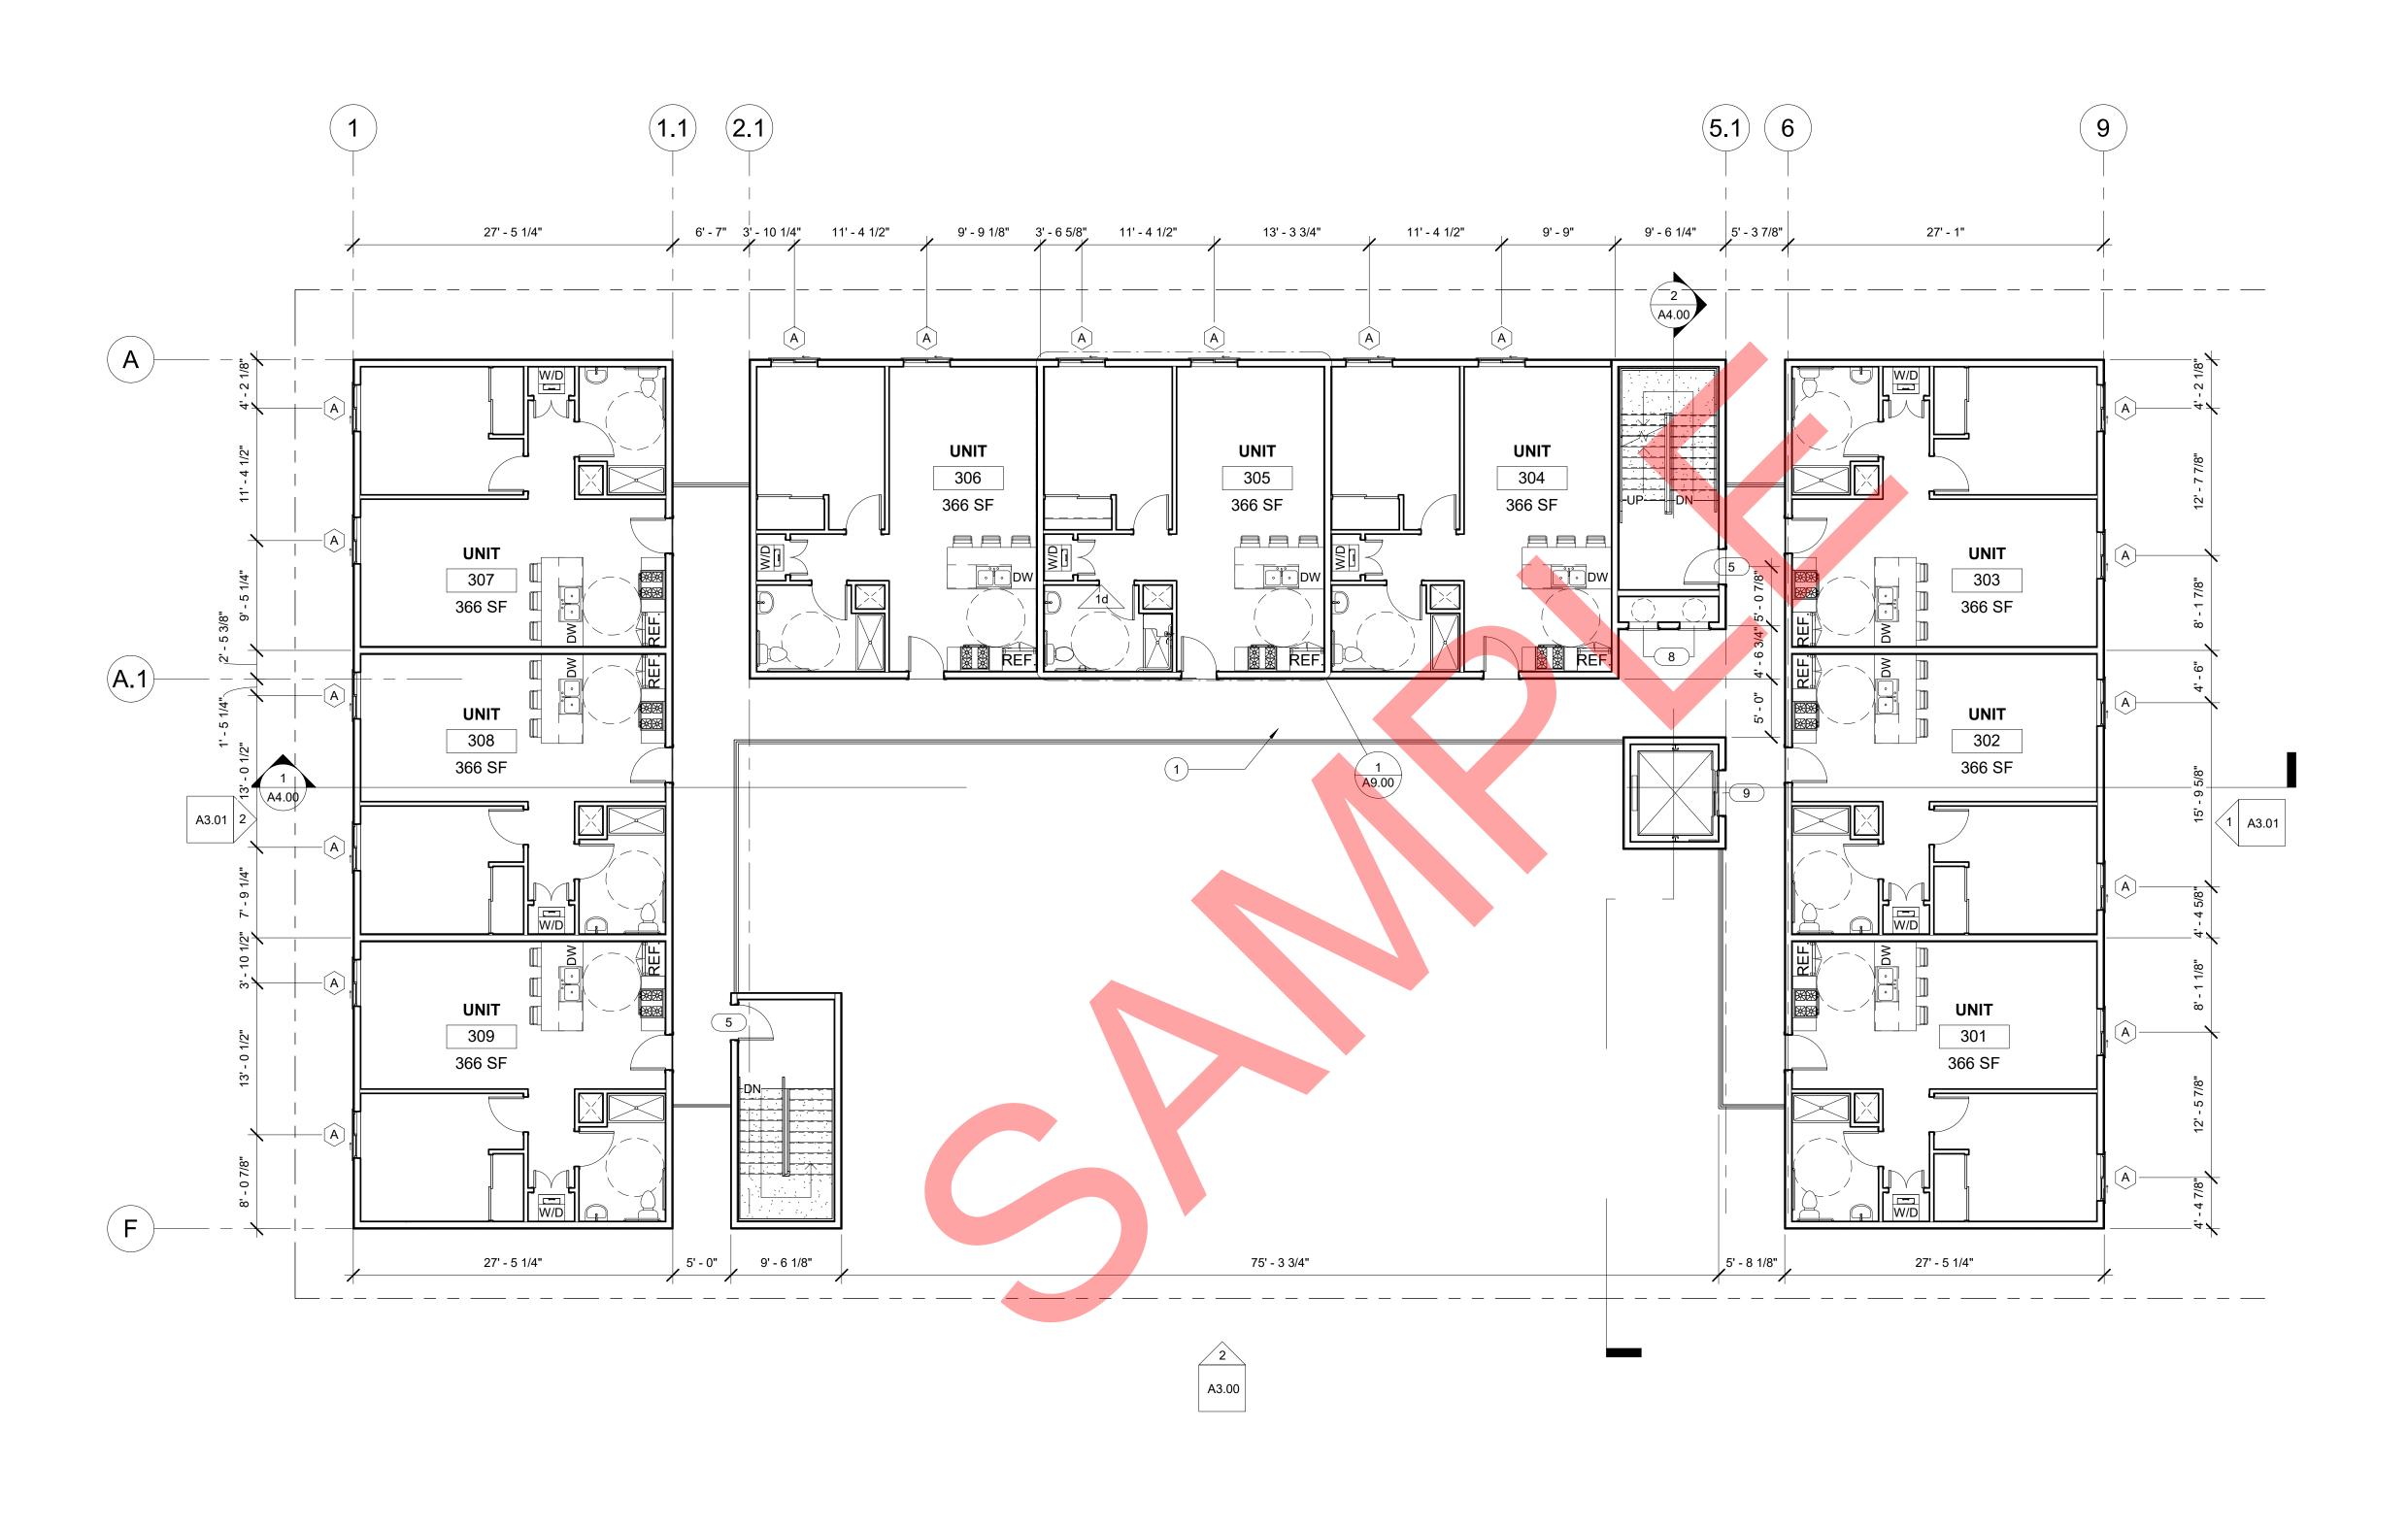

1 THIRD LEVEL
1/8" = 1'-0"

The enclosed drawings, designs, ideas and arrangements, as contracted with their clients and consultants, are and shall remain the property of The Architect of Record. No part thereof shall be copied, disclosed to others, or used in connection with any other work or project without the written consent of the above. Visual contact with these prints shall constitute conclusive evidence of these restrictions.

#### CONSTRUCTION NOTES:

1. WALK WAY

#### Architect of Record

Los Angeles, CA 90015 Cell: 213 - x x x - x x x E m ail: x x x@.com

Project Name
Project address
Project address



Owner's Name
Owner's Street Address
City, CA 90015

H THIRD LEVEL PLAN

#### CONSTRUCTION DOCUMENTS


PROJECT NU	MBER	Project Number
No.	Date	Submission

Date	Issue Date
Drawn by	XX
Checked by	XX

A2.03

1/0" - 1



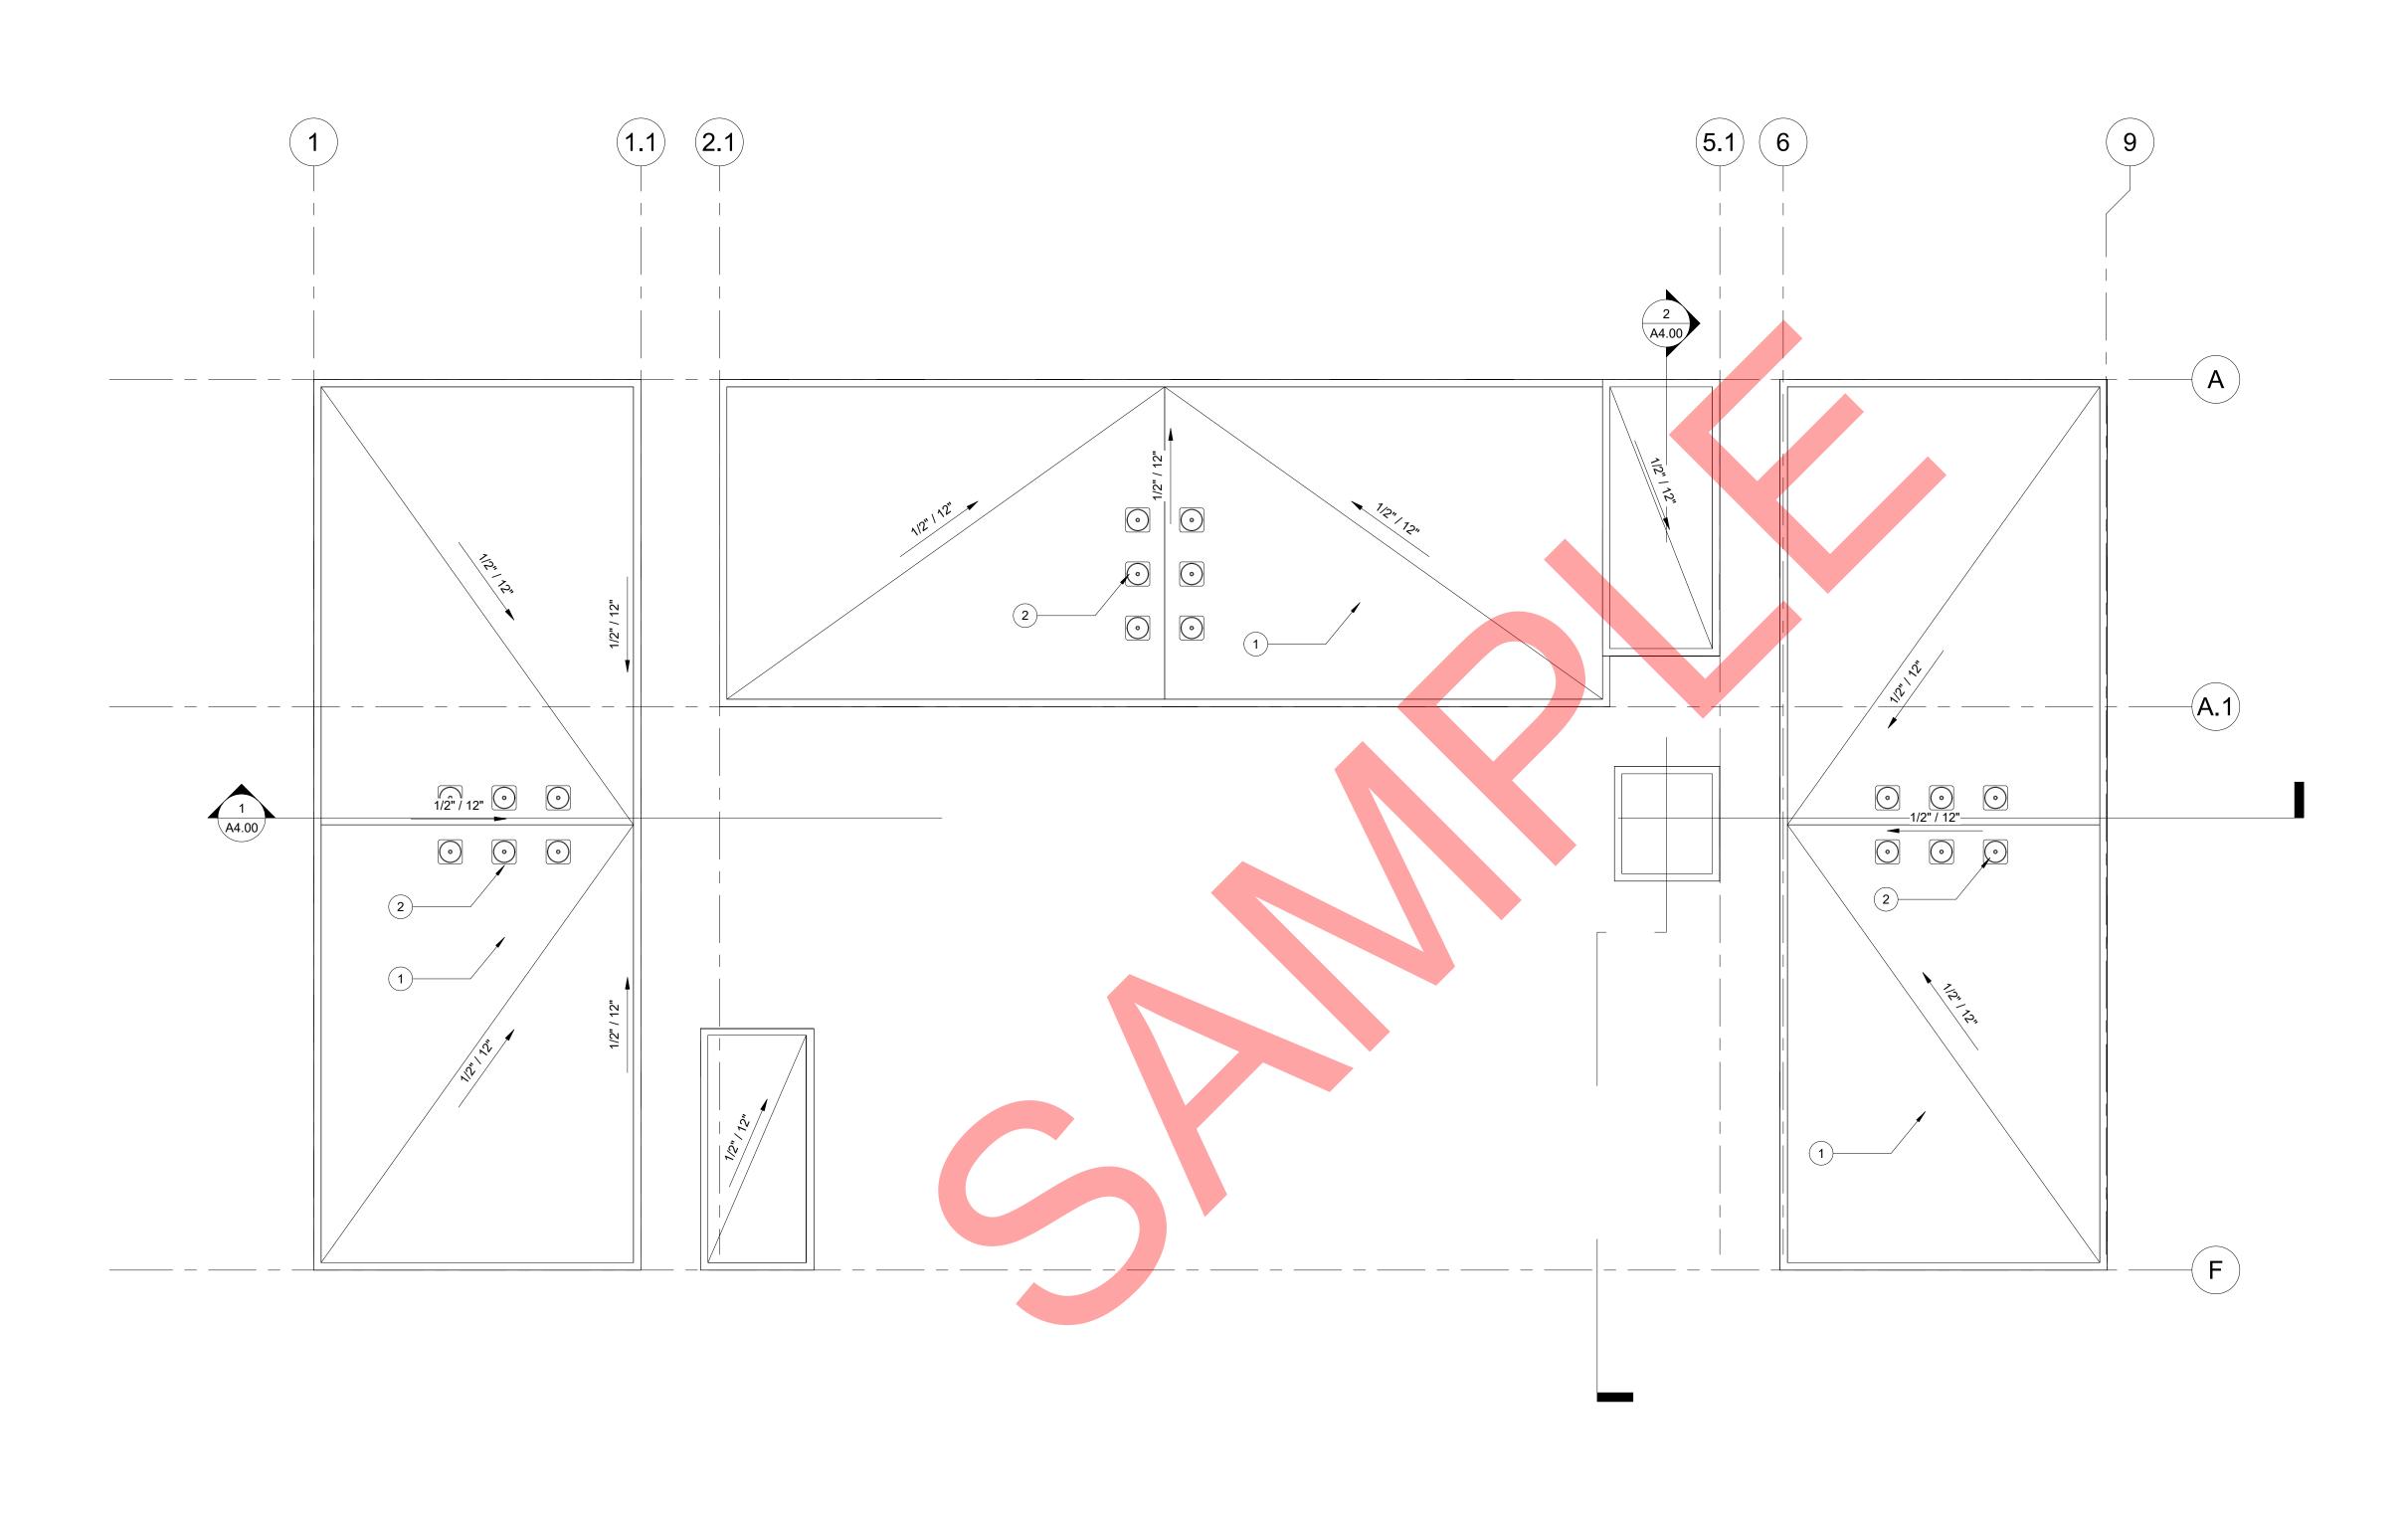

1 ROOF PLAN 1/8" = 1'-0"

The enclosed drawings, designs, ideas and arrangements, as contracted with their clients and consultants, are and shall remain the property of The Architect of Record. No part thereof shall be copied, disclosed to others, or used in connection with any other work or project without the written consent of the above. Visual contact with these prints shall constitute conclusive evidence of these rectrictions. these restrictions.

#### CONSTRUCTION NOTES:

- ULTRAPLY TPO SINGLE-PLY COOL ROOF W/ MIN 75 SRI, "CLASS A"
- 2. ROOFTOP AC UNIT

Architect of Record

Los Angeles, CA 90015 Cell:213-xxx-xxxx Email:xxx@.com

> Project Name Project address Project address



Owner's Name
Owner's Street Address
City, CA 90015

ROOF PLAN

#### CONSTRUCTION DOCUMENTS

PROJECT NI	JMBER	Project Number
No.	Date	Submission

Date	Issue Date
Drawn by	XX
Checked by	XX

1/8" = 1'-0"

A2.04

The enclosed drawings, designs, ideas and arrangements, as contracted with their clients and consultants, are and shall remain the property of The Architect of Record. No part thereof shall be copied, disclosed to others, or used in connection with any other work or project without the written consent of the above. Visual contact with these prints shall constitute conclusive evidence of these restrictions.

#### **CONSTRUCTION NOTES:**

- CEMENT PLASTER FINISH, SMOOTH
- 2. CMU BLOCK, W/INTEGRAL COLOR
- FIBER CEMENT SIDING

PROVIDE ANTI-GRAFFITI FINISH WITHIN THE FIRST 9 FEET, MEASURED FROM GRADE, AT EXTERIOR WALLS AND DOORS. EXCEPTION: MAINTENANCE OF BUILDING
AFFIDAVIT IS RECORDED BY THE OWNER TO COVENANT
AND AGREE WITH THE CITY OF LOS ANGELES TO
REMOVE ANY GRAFFITI WITHIN 7-DAYS OF THE GRAFFITI
BEING APPLIED. (6306)

#### Architect of Record

Los Angeles, CA 90015 Cell:213-xxx-xxxx Email:xxxæ.com

Project Name Project address Project address



Owner's Name Owner's Street Address City, CA 90015

#### **ELEVATIONS**

#### CONSTRUCTION DOCUMENTS

PROJECT NUMBER	Project Number
No. Date	Submission

Date	Issue Date
Drawn by	XX
Checked by	XX

A3.00



The enclosed drawings, designs, ideas and arrangements, as contracted with their clients and consultants, are and shall remain the property of The Architect of Record. No part thereof shall be copied, disclosed to others, or used in connection with any other work or project without the written consent of the above. Visual contact with these prints shall constitute conclusive evidence of these restrictions.

#### **CONSTRUCTION NOTES:**

- CEMENT PLASTER FINISH, SMOOTH
- 2. CMU BLOCK, W/INTEGRAL COLOR
- 3. FIBER CEMENT SIDING
- 4. SHORT TERM BICYCLE STORAGE

PROVIDE ANTI-GRAFFITI FINISH WITHIN THE FIRST 9 FEET, MEASURED FROM GRADE, AT EXTERIOR WALLS AND DOORS. EXCEPTION: MAINTENANCE OF BUILDING AFFIDAVIT IS RECORDED BY THE OWNER TO COVENANT AND AGREE WITH THE CITY OF LOS ANGELES TO REMOVE ANY GRAFFITI WITHIN 7-DAYS OF THE GRAFFITI BEING APPLIED. (6306)

#### Architect of Record

Los Angeles, CA 90015 C e II : 2 1 3 - x x x - x x x x E m a iI : x x x@.com

Project Name Project address

Project address



- Owner's Name Owner's Street Address City, CA 90015


#### ELEVATIONS

#### CONSTRUCTION DOCUMENTS

Date	Issue Date
Drawn by	X
Checked by	Y)

A3.01

#### **CONSTRUCTION NOTES:**

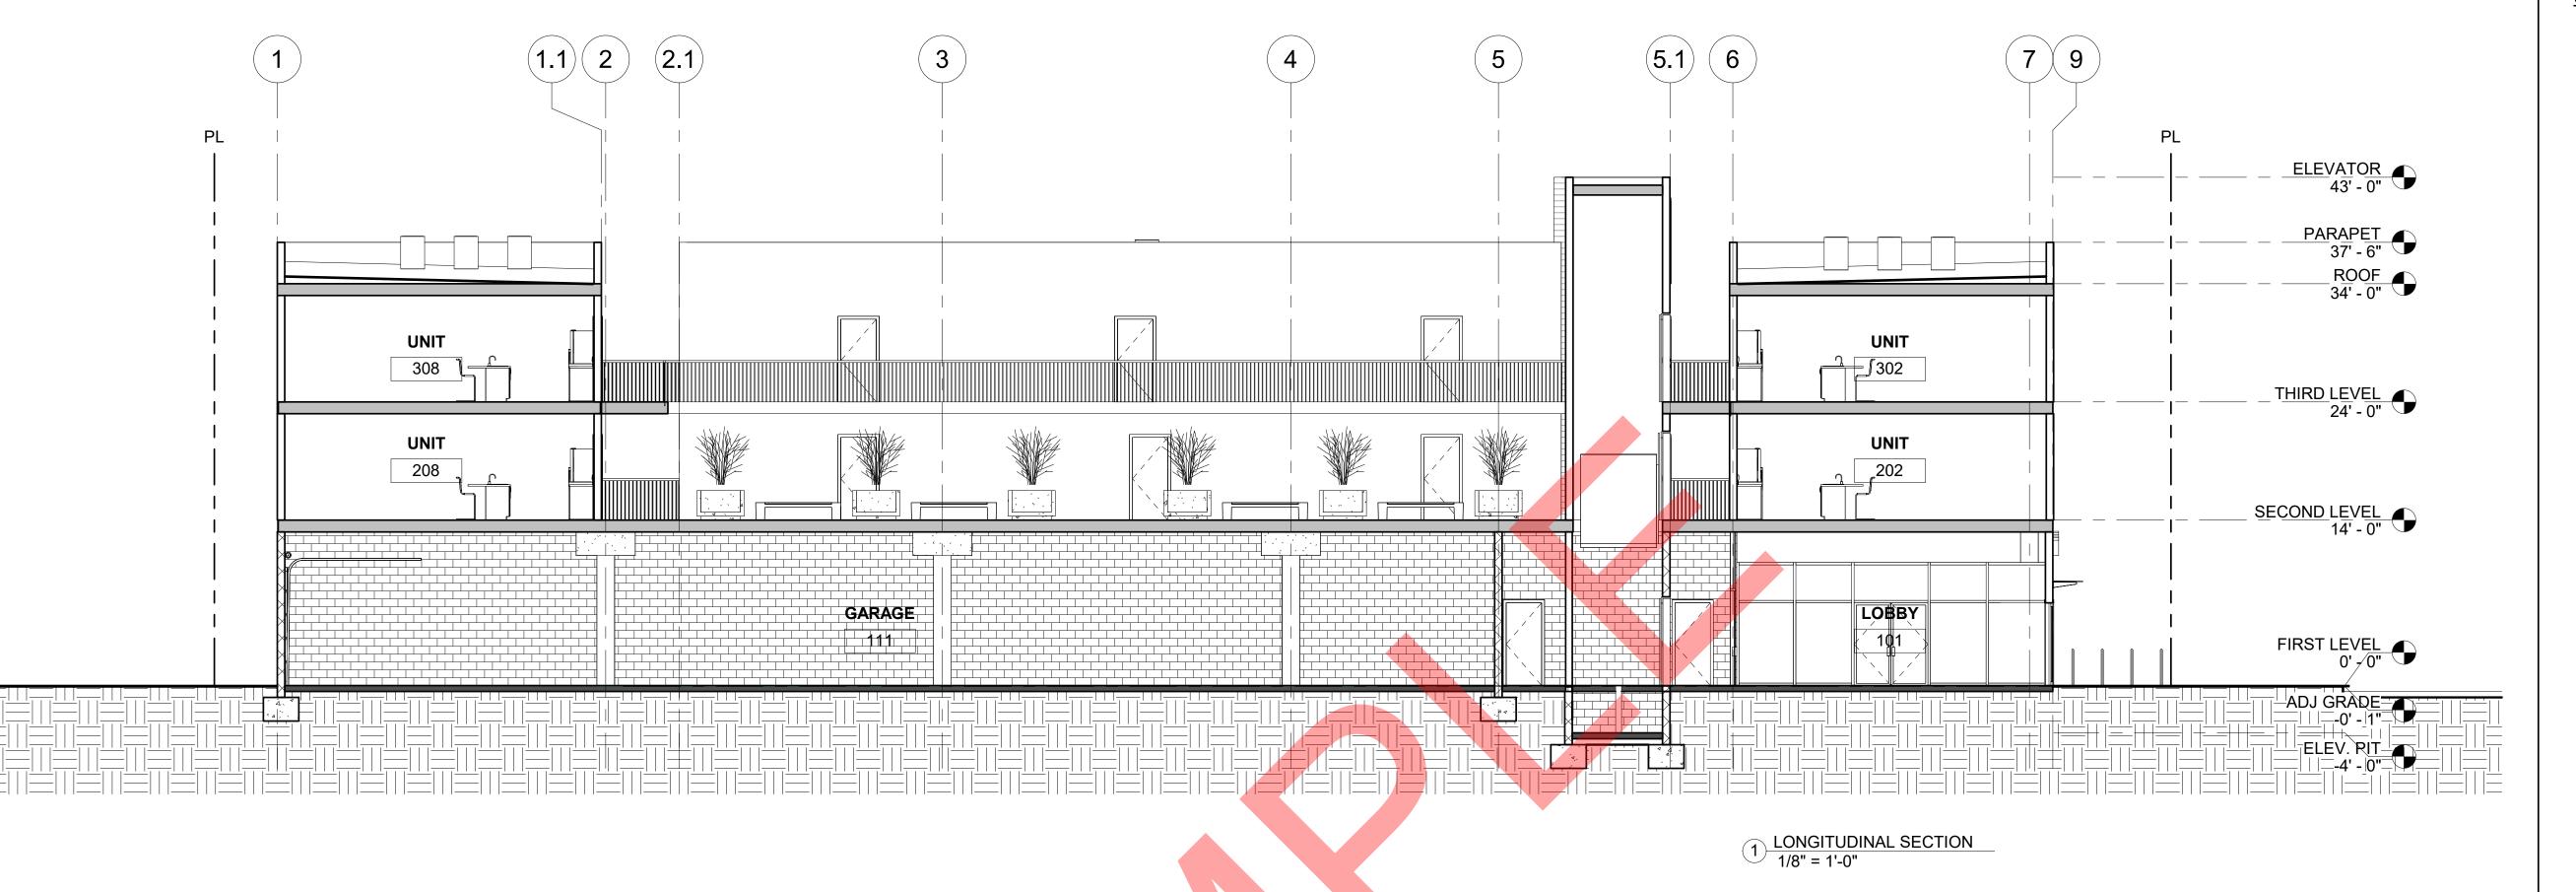

PARAPET 437-07

PARAPET 437-07

PARAPET 437-07

THIRD LEVEL 24-07

SECOND LEVEL 417-07

TRANSFIR BOYCLE STORAGE FIRST LEVEL 0/07

ADJ GRADE 0/07

ADJ GRADE 0/07

THANSVERSE SECTION 188' = 1-07

#### Architect of Record

Los Angeles, CA 90015 Cell: 213 - x x x - x x x E m ail: x x x@.com

Project Name
Project address
Project address



Owner's Name
Owner's Street Address
City, CA 90015

#### E SECTIONS

#### CONSTRUCTION DOCUMENTS


PROJECT NUMBER		Project Number
No.	Date	Submission
_	_	_


l		
l	Date	Issue Date
l	Drawn by	XX
l	Checked by	XX


A4.00

TYPICAL WALL : (OUTSIDE IN)

FINISH COAT **BROWN COAT** SCRATCH COAT WIRE LATH

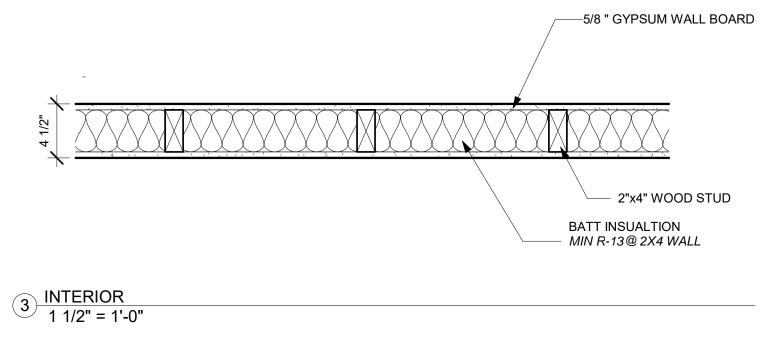

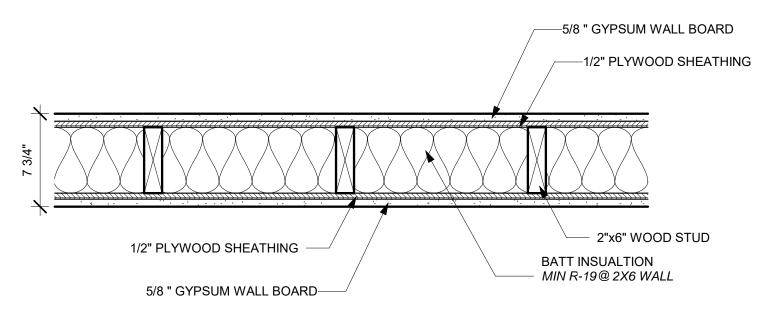

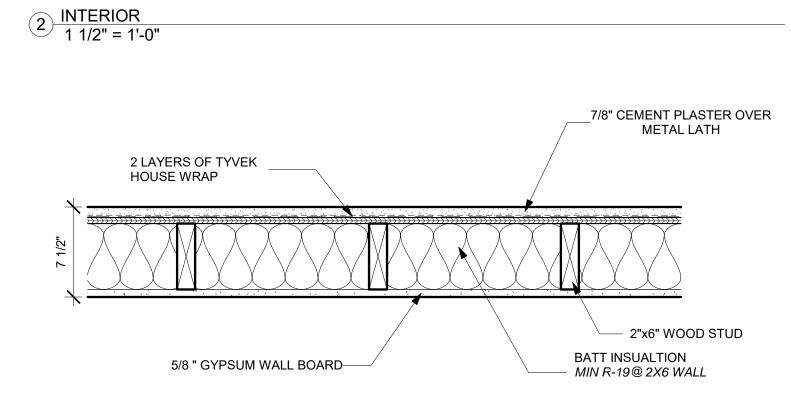

1 EXTERIOR 1 1/2" = 1'-0"

The enclosed drawings, designs, ideas and arrangements, as contracted with their clients and consultants, are and shall remain the property of The Architect of Record. No part thereof shall be copied, disclosed to others, or used in connection with any other work or project without the written consent of the above. Visual contact with these prints shall constitute conclusive evidence of these restrictions.

**CONSTRUCTION NOTES:** 

Architect of Record

Los Angeles, CA 90015 C e II : 2 1 3 - x x x - x x x x E m a iI : x x x@.com

Project Name Project address Project address



Owner's Name Owner's Street Address City, CA 90015

WALL TYPES & DETAILS


#### CONSTRUCTION DOCUMENTS

PROJECT NUM	MBER	Project Numbe
No.	Date	Submission

Date	Issue Date
Drawn by	XX
Checked by	XX

A5.00

1 1/2" = 1'-0"

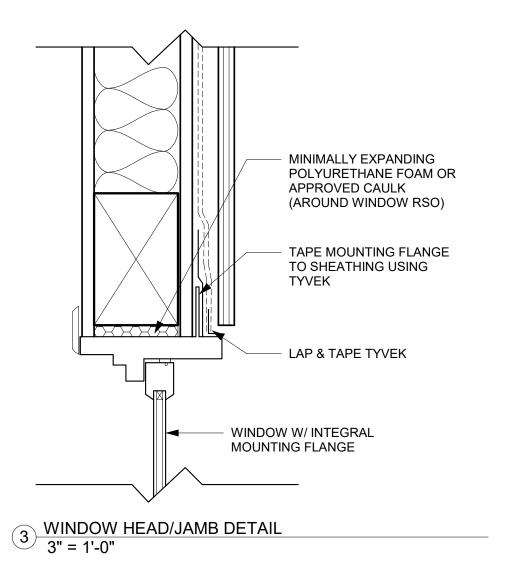

R-19 INSULATION

5/8" TYPE 'X' G.W.B.

4x DOOR HEADER (SEE STRUCT. DWGS.)


WOOD DOOR


WOOD DOOR

FRAME


2 DOOR 3" = 1'-0"

FRAME TRIM

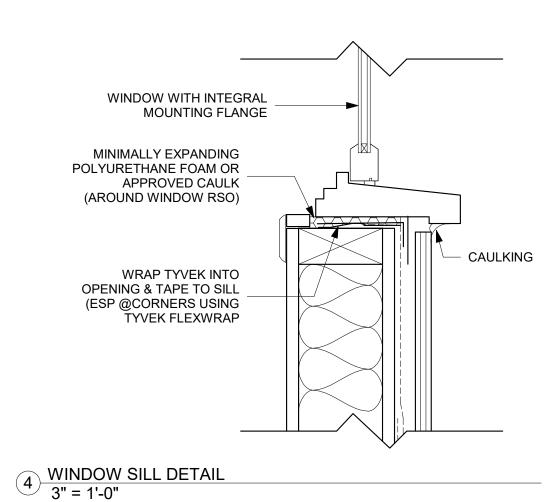

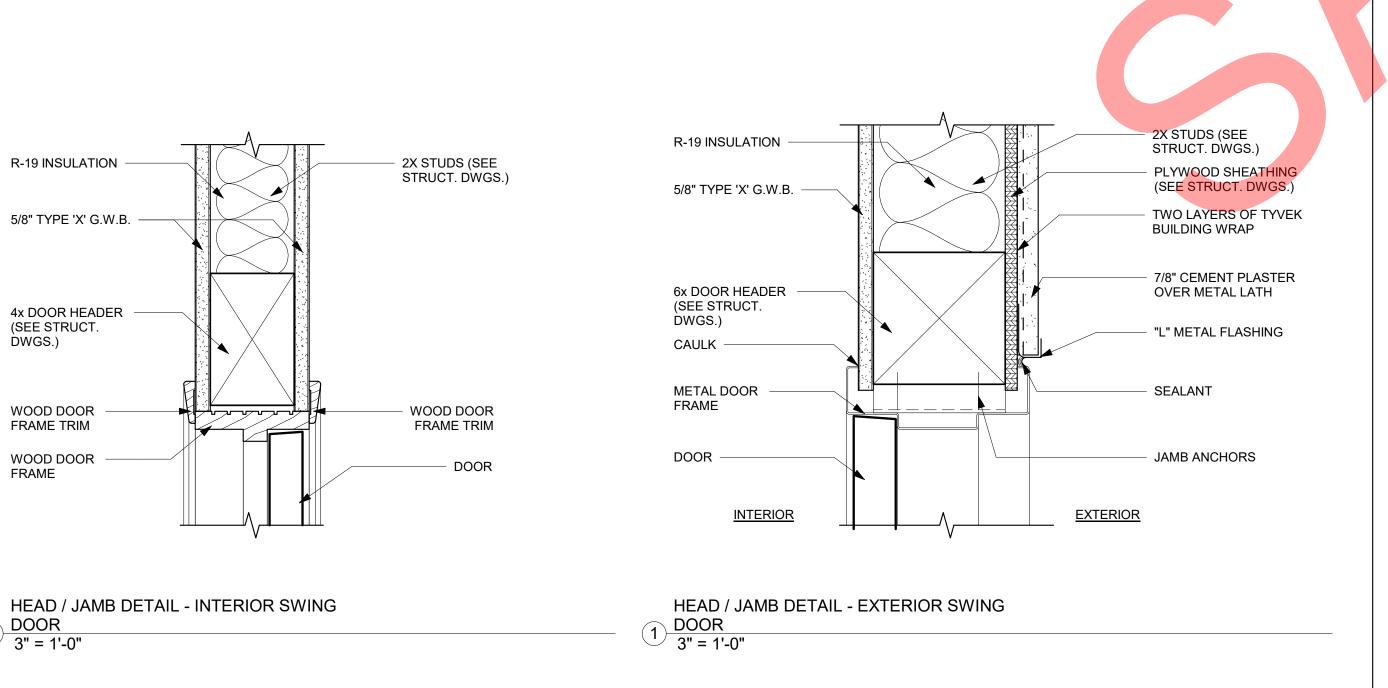

							WINDOW	SCHEDUL	E					
WIN	DOW			WI	NDOW		GLAZ	ZING	FR	AME	DET	AILS		
					H OPENING ENSIONS			ĸ	ERIAL	I			_	
NO.	TYPE	Type Comments	Туре	WIDTH	HEIGHT	Sill Height	TYPE	COLC	MATE	FINIS	HEAD /JAMB	SILL	REMARKS	Model
Α	1	SLIDING	48" x 60"	4' - 0 1/2"	5' - 0 1/2"	3' - 6"	LOW-E3	CLR	VYL	BRZ	3/A8.00	4/A8.00	TEMPERED	

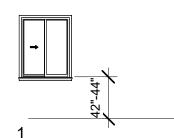


WINDOW TYPE 1/8" = 1'-0"

LLG	
AA	ANODIZED
AF	ALUMINUM
CL	CLEAR
DG	DOUBLE GLAZ
FF	FACTORY FIN
GL	GLASS
M	METAL
0	OPERABLE
PF	PAINT FINISH
SG	SINGLE GLAZ
VYL	VINYL

#### **NOTES**

VERIFY ALL DIMENSIONS AT FIELD BEFORE MANUFACTURING

DOOR SCHEDULE DOOR ਰ DETAILS SHEET NO. DIMENSIONS EXT HEAD INT HEAD / HEIGHT REMARKS / JAMB JAMB 7' - 0" 1/A8.00 0' - 2" 3' - 0" Yes WD PF HC WD 6' - 8" 3' - 0" 0' - 1 3/4" 2/A8.00 HC WD PF 5' - 8" 7' - 0" 2/A8.00 7' - 0" WD PF HC WD PF 2/A8.00 3' - 0" 3' - 0" 7' - 0" 1/A8.00 <varies> <varies> 6' - 0" 1/A8.00 3' - 0" 7' - 0" 1/A8.00 2' - 6" 2' - 6" 3' - 0" 7' - 6" 3' - 0" 6' - 3" 7' - 0" 0' - 2" ALM FF HC ALM FF Yes Yes 12 K 6' - 0" 7' - 0" 0' - 2" ALM FF HC ALM FF Yes Yes MTL PF HC MTL PF 16' - 0"

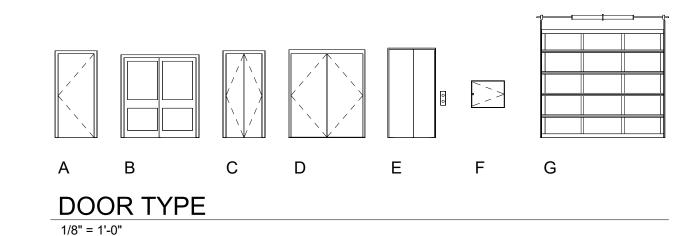

#### **LEGEND**

ALM	ALUMINUM
CD	CLOSER DEVICE
DP	DOUBLE PANE
FF	FACTORY FINISH
FRP	FIBERGLASS REINFORCED
GL	GLASS
HC	HOLLOW CORE
HM	HOLLOW METAL
MTL	METAL
PF	PAINT FINSH
SC	SOLID CORE
ST	STEEL TUBE
WD	WOOD

WEATHER STRIP

#### **NOTES**

- 1. ALL SECURITY OPENINGS SHALL COMPLY WITH DIVISION 67 OF THE LOS ANGELES CURRENT BUILDING CODE INCLUDING THE FOLLOWING
- ALL PIN TYPE HINGES WHICH ARE ACCESSIBLE FROM OUTSIDE THE SECURED AREA WHEN THE DOOR IS CLOSED SHALL HAVE NON-REMOVABLE HINGE PINS.
- DEADBOLTS SHALL CONTAIN HARDENED INSERTS.

  STRAIGHT DEADBOLTS SHALL HAVE A MINUMUM THROW OF 1" AND AN EMBEDMENT OF 1/4".

  A HOOK SHAPED OR AN EXPANDING LUG DEADBOLT SHALL HAVE A MINUMUM THROW OF 1/4".
- CYLINDER GUARDS SHALL BE INSTALLED IN ALL CYLINDER LOCKS WHENEVER THE CYLINDER PROJECTS BEYOND THE FACE OF
- THE DOOR OR IS OTHERWISE ACCESSIBLE TO GRIPPING TOOLS.
- ALL GLASS DOORS SHALL HAVE FULLY TEMPERED GLASS. PROVIDE DEADLOCKING LATCH KEY OPERATED LOCKS ON EXTERIOR.
- ALL GLAZING WITHIN 40" OF DOOR LOCK SHALL BE TEMPERED GLASS. DOOR STOPS OF IN-SWINGING EXTERIOR DOORS SHALL BE ONE PIECE CONSTRUCTION.

The enclosed drawings, designs, ideas and arrangements, as contracted with their clients and consultants, are and shall remain the property of The Architect of Record. No part thereof shall be copied, disclosed to others, or used in connection with any other work or project without the written consent of the above. Visual contact with these prints shall constitute conclusive evidence of these restrictions.

#### CONSTRUCTION NOTES:

#### Architect of Record

Los Angeles, CA 90015 Cell: 213-xxx-xxxx Email:xxxx@.com

Project Name Project address Project address



Owner's Name Owner's Street Address

City, CA 90015

SCHEDULES


#### CONSTRUCTION DOCUMENTS


Submission
-

D   VV	Date	Issue Date
Drawn by XX	Drawn by	XX
Checked by XX	Checked by	XX

A8.00



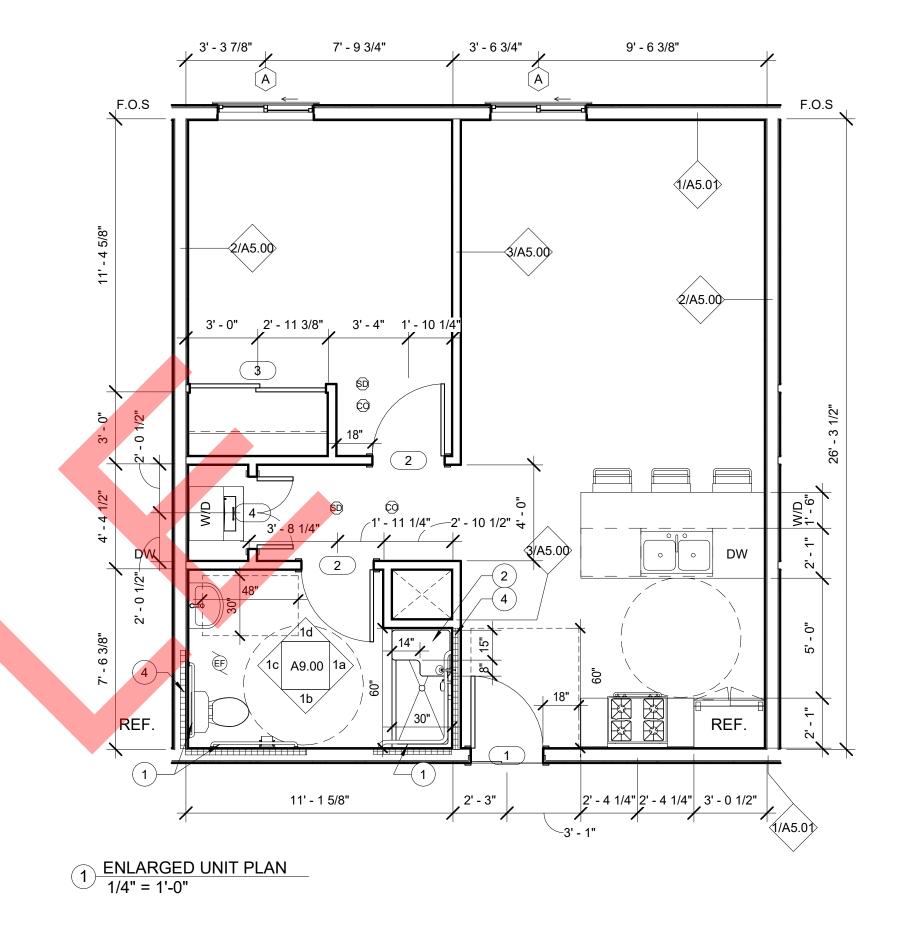

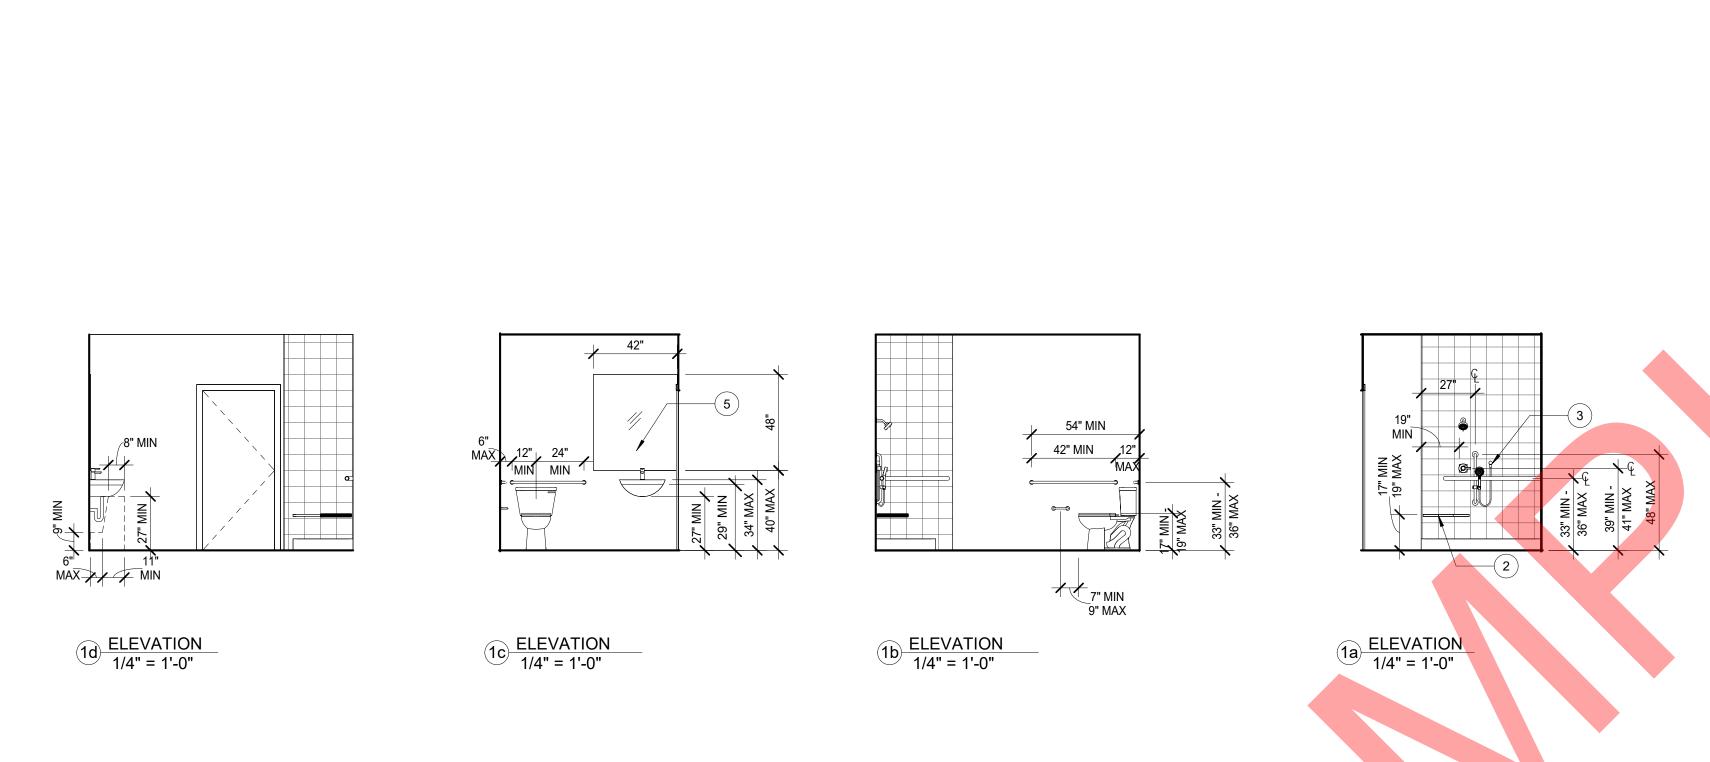

The enclosed drawings, designs, ideas and arrangements, as contracted with their clients and consultants, are and shall remain the property of The Architect of Record. No part thereof shall be copied, disclosed to others, or used in connection with any other work or project without the written consent of the above. Visual contact with these prints shall constitute conclusive evidence of these restrictions.

#### **CONSTRUCTION NOTES:**

- 1. 2" DIA GRAB BAR
- SHOWER SEAT
- HANDHELD SHOWER HEAD W/ MIN 59" LONG FLEXIBLE HOSE
- GRAB BAR BACKING
- MIRROR

1 HR SEPARATION (PER TABLE R302.6) EF EXHAUST FAN, ENERGY STAR RATED, W/ HUMIDITY SENSOR

SMOKE DETECTOR

© CARBON MONOXIDE DETECTOR 11" CLOSET SHELF & POLE

WATER CLOSET, MAX 1.28 GPF

SHOWER W/ SINGLE SHOWERHEAD, MAX 2 GPM @80 PSI FLOW RATE

LAVATORY, MAX 1.5 - MIN 0.80 GPM

KITCHEN SINK W/ KITCHEN FAUCET, MAX 1.8 GPM@60 PSI FLOW RATE

EV FUTURE EV CHARGER LOCATION, LABEL "EV CAPABLE".

CEILING FAN, ENERGY STAR

#### LEGEND

Architect of Record Los Angeles, CA 90015 C e II : 2 1 3 - x x x - x x x x E m a iI : x x x@.com

Project Name Project address

Project address



Owner's Name Owner's Street Address City, CA 90015

ENLARGED PLANS

#### CONSTRUCTION DOCUMENTS

PROJECT NUMBER		Project Number
No.	Date	Submission
_	-	-

Issue Date Drawn by XX Checked by XX

A9.00

# STURUCTURAL PLANS PER ENGINEER'S DESIGN